
FIXTURE SCHEDULE							
SYM.	DESCRIPTION	НОТ	COLD	WASTE	VEN		
CW-1	COLD FOOD WELL K.E.C #52 - SUPPLIED BY K.E.C. PLUMBING CONTRACTOR TO CONNECT 1" DRAIN LINE FROM UNIT TO FLOOR SINK LOCATED UNDER CABINET AND TERMINATE WITH DOWNTURNED 90° ELBOW AND AIRGAP.			1"			
DS-1	ROOF DRAIN DOWN SPOUT - JAY R SMITH MODEL 1770 SIZE 3" WITH ROUGH BRONZE FINISH AND 3" DRAIN LINE CONNECTION.			3"			
DS-2	ROOF OVERFLOW DRAIN DOWN SPOUT - JAY R SMITH MODEL 1770 SIZE 3" WITH ROUGH BRONZE FINISH AND 3" DRAIN LINE CONNECTION.			3"			
FS-1	FLOOR SINK - ZURN Z-1900-KC WITH WHITE ENAMEL FINISH, DOME STRAINER AND 4" DEEP SEAL P-TRAP. PROVIDE 1/2 GRATE OVER SINK.			4"	2"		
HS-1	ADA WALL MOUNTED HAND WASH SINK K.E.C #16- S.S. HAND WASH SINK & FAUCET SUPPLIED BY K.E.C. PLUMBING CONTRACTOR TO INSTALL SINK & FAUCET WITH 1/2" STOPS AND 1-1/2" P-TRAP. PROVIDE INSULATING JACKET ON WATER AND WASTE PIPE.	1/2"	1/2"	1-1/2"	1-1/2		
(HW-1)	HOT FOOD WELL K.E.C #51 - SUPPLIED BY K.E.C. PLUMBING CONTRACTOR TO CONNECT 1" DRAIN LINE FROM EACH COMPARTMENT OF UNIT TO FLOOR SINK LOCATED UNDER CABINET AND TERMINATE WITH DOWNTURNED 90° ELBOW AND AIRGAP.			1"			
HW-2	HOT FOOD WELL K.E.C #52 - SUPPLIED BY K.E.C. PLUMBING CONTRACTOR TO CONNECT 1" DRAIN LINE FROM UNIT TO FLOOR SINK LOCATED UNDER CABINET AND TERMINATE WITH DOWNTURNED 90° ELBOW AND AIRGAP.			1"			
IM-1	ICE MAKER WITHOUT ICE BIN K.E.C #6 - SUPPLIED BY K.E.C. PLUMBING CONTRACTOR TO CONNECT 3/8" CW LINE TO UNIT AND 3/4" DRAIN LINE FROM UNIT TO FLOOR SINK LOCATED UNDER CABINET AND TERMINATE WITH DOWNTURNED 90° ELBOW AND AIRGAP.		3/8"	3/4"			
IB-1	ICE BIN K.E.C #7 - SUPPLIED BY K.E.C. PLUMBING CONTRACTOR TO CONNECT 1" DRAIN LINE FROM UNIT TO FLOOR SINK LOCATED UNDER CABINET AND TERMINATE WITH DOWNTURNED 90° ELBOW AND AIRGAP.			1"			
IM-2	DRIVE THRU ICE MAKER K.E.C #41.2 - SUPPLIED BY K.E.C. PLUMBING CONTRACTOR TO CONNECT 3/8" CW LINE TO UNIT AND 1" DRAIN LINE FROM UNIT TO FLOOR SINK LOCATED UNDER CABINET AND TERMINATE WITH DOWNTURNED 90° ELBOW AND AIRGAP.		3/8"	1"			
OD-1	ROOF OVERFLOW DRAIN - JAY R SMITH MODEL 1080 SIZE 3" WITH 2" HIGH WATER DAM, UNDERDECK CLAMP AND FLASHING.			3"			
RD-1	ROOF DRAIN - JAY R SMITH MODEL 1010 SIZE 3" WITH UNDERDECK CLAMP AND FLASHING.			3"			
TG-1	GAS FIRED TORTILLA GRIDDLE K.E.C. #37- SUPPLIED BY K.E.C. PLUMBING CONTRACTOR TO CONNECT 3/4" GAS LINE COMPLETE WITH SHUT-OFF VALVE, FLEXIBLE CONNECTION AND DIRT LEG. SEE FLOOR PLANS. 50,000 BTU CAPACITY						
TL-1	TO GO LINE FAUCET K.E.C #49 - SUPPLIED BY K.E.C. PLUMBING CONTRACTOR TO CONNECT 1/2" HW LINE COMPLETE WITH BALL TYPE SHUT-OFF VALVE AND S.S. BRAIDED FLEXIBLE CONNECTION.	1/2"					

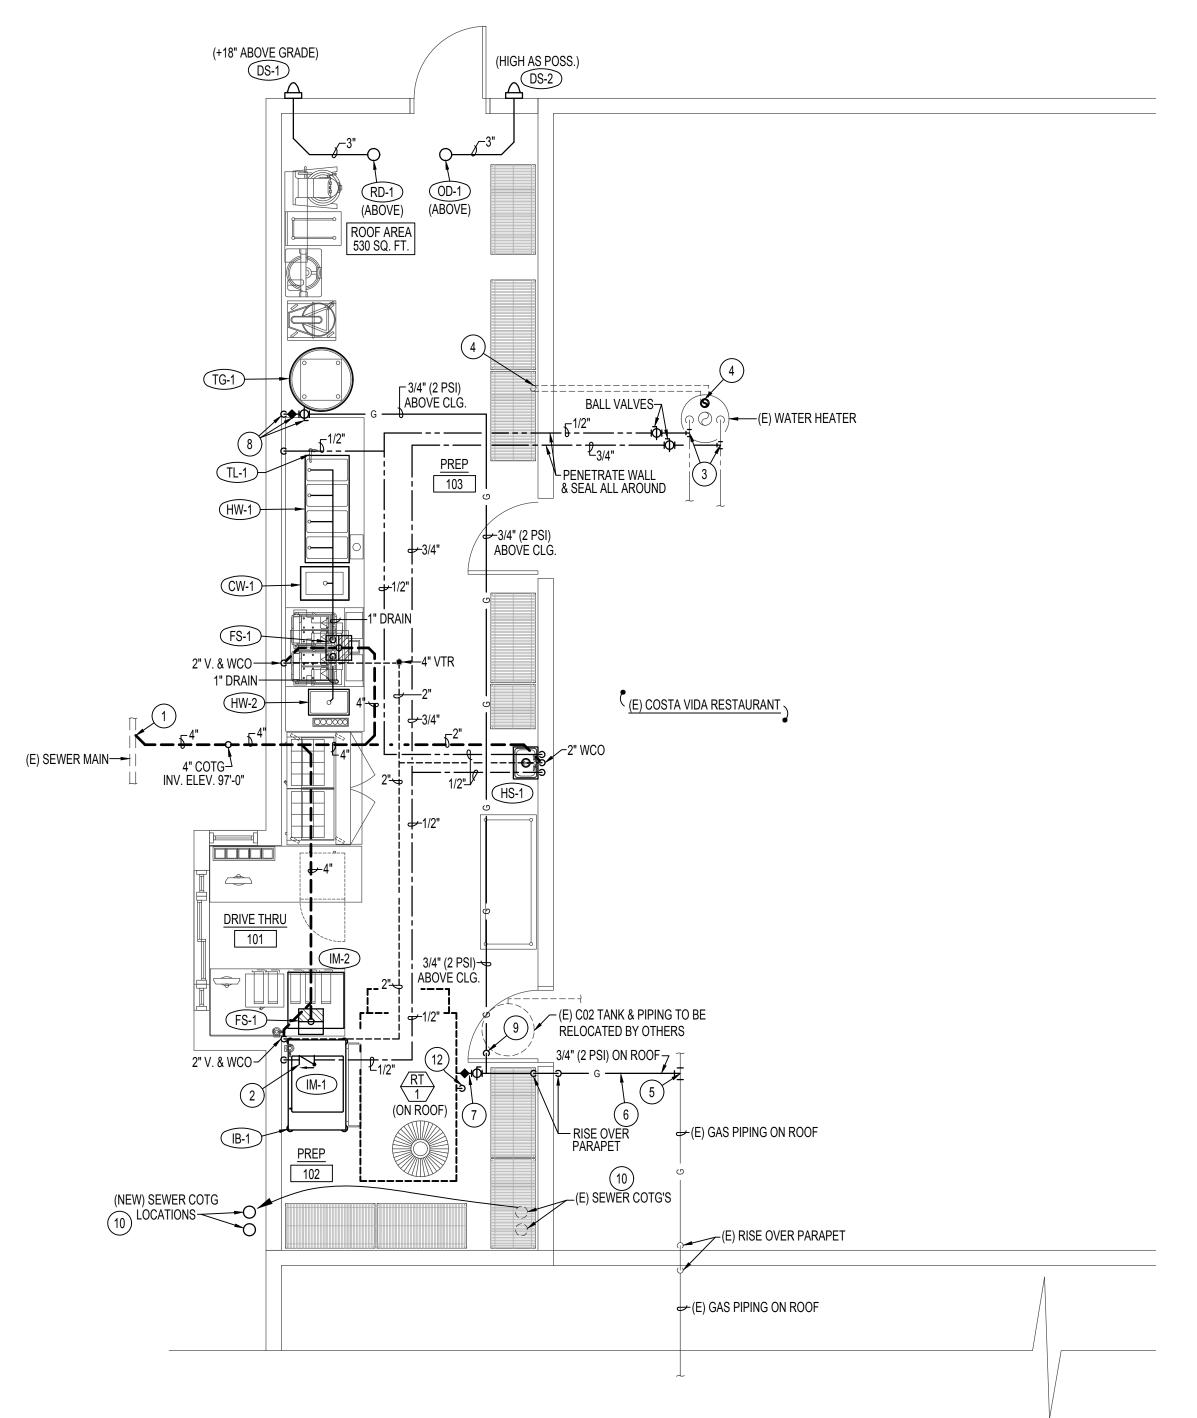

FLOOR PLAN - PLUMBING SCALE: 1/4" = 1'-0"



PLAN NOTES:

- CONNECT NEW 4" WASTE LINE TO EXISTING 4" OR LARGER SEWER. FIELD VERIFY EXACT LOCATION AND DIRECTION OF FLOW OF EXISTING SEWER MAIN.
- 2) INSTALL 1/2" BACKFLOW PREVENTOR ON 1/2" CW LINE SERVING (2) ICE MAKERS. RUN DRAIN LINE TO FLOOR SINK BELOW WITH AIR GAP. SEE DETAIL ON SHEET P2.0
- 3 CONNECT NEW 3/4" CW AND 1/2" HW LINES TO EXISTING 3/4" HOT AND COLD WATER LINES AT WATER HEATER. FIELD VERIFY EXACT LOCATION OF EXISTING PIPING.
- (4) RELOCATE EXISTING 4" PVC INTAKE AND CONNECT TO EXISTING INTAKE ON ROOF NEXT TO EXISTING WATER HEATER FLUE. FIELD VERIFY EXISTING CONDITIONS.
- 5) CONNECT NEW 3/4" (2 PSI) GAS LINE TO EXISTING 3/4" (2 PSI) OR LARGER GAS LINE ON ROOF. FIELD VERIFY EXISTING LOCATION OF GAS LINE.
- (6) INSTALL NEW GAS LINE ON ROOF ON ERICO PIPE PIER SUPPORTS OR APPROVED EQUAL AT 10'-0" ON CENTER.
-) INSTALL 2 PSI TO OZ. GAS REGULATOR ON 3/4" GAS LINE SERVING NEW RTU SIZED FOR ACTUAL BTU LOAD OF UNIT SUPPLIED. CONNECT NEW 3/4" (OZ.) GAS LINE TO UNIT COMPLETE WITH SHUT-OFF VALVE, DIRT LEG AND FLEXIBLE CONNECTION. SEE DETAIL ON SHEET P2.0.
- 8) DROP 3/4" (2 PSI) GAS LINE DOWN EXPOSED ON INTERIOR SIDE OF WALL TO SERVE GAS FIRED TORTILLA GRIDDLE. INSTALL 2 PSI TO OZ. GAS REGULATOR ON GAS LINE SIZED FOR ACTUAL BTU LOAD OF GRIDDLE SUPPLIED. CONNECT 3/4" (OZ.) GAS LINE TO GRIDDLE COMPLETE WITH SHUT-OFF VALVE, FLEXIBLE CONNECTION AND DIRT LEG. SEE DETAIL ON SHEET P2.0
- 9) DROP 3/4" (2 PSI) GAS LINE DOWN THRU ROOF TO CEILING SPACE AND RUN AS SHOWN TO SERVE TORTILLA GRIDDLE. SEAL ROOF PENETRATION WEATHERTIGHT.
- 10) RELOCATE EXISTING SEWER CLEAN OUT TO GRADE TO NEW LOCATION OUTSIDE OF NEW ADDITION. FIELD VERIFY EXISTING SEWER LOCATION AND MODIFY AS REQUIRED.
- 12) RUN 3/4" CONDENSATE DRAIN LINE FROM ROOFTOP UNIT TO ROOF AS SHOWN ON DETAIL ON SHEET P2.0

BRENT A. MCFARLAND AR-2561
STATE OF IDAHO



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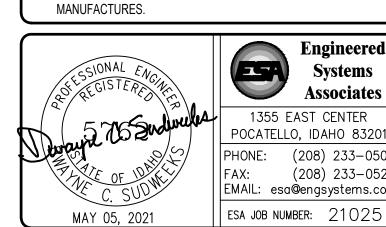
ELECTRICAL ENGINEERING Payne Engineering INC. 1832 East Center Street Pocetello, Idaho 83201 Tel:(208) 232-4439 Fax:(208) 232-1435

PLUMB	PLUMBING LEGEND				
SYMBOL	DESCRIPTION				
V	VENT				
VTR	VENT THRU ROOF				
CO	CLEANOUT				
WCO	WALL CLEANOUT				
COTG	CLEANOUT TO GRADE				
e	PIPE DROP				
O	PIPE RISE				
——Ф——	BALL TYPE ISOLATION VALVE				
	SOIL OR WASTE PIPING				
 GW 	GREASE WASTE PIPING				
	VENT LINE PIPING				
	DOMESTIC SOFT COLD WATER				
	DOMESTIC HOT WATER PIPING				
	DOMESTIC HOT WATER RECIRC.				
RDL	ROOF DRAIN PIPING				
RDO	ROOF OVERFLOW DRAIN PIPING				
	l				

GENERAL NOTES:

— G — NATURAL GAS PIPING

- A- THE CONTRACTOR SHALL CHECK AND VERIFY ALL DIMENSIONS AND CONNECTIONS ON THE JOB SITE. ALL WORK SHALL BE EXECUTED FROM MEASUREMENTS TAKEN AT THE SITE.
- B- THE MECHANICAL CONTRACTOR SHALL BE RESPONSIBLE TO INSURE PROPER CODE CLEARANCES FOR ELECTRICAL AND MECHANICAL ACCESS WHEN INSTALLING ANY EQUIPMENT SUPPLIED BY THE MECHANICAL CONTRACTOR.
- C- IT IS CRITICAL THAT THIS CONTRACTOR COORDINATE EQUIPMENT LOCATIONS WITH PIPING, DUCTWORK, ELECTRICAL CONDUIT AND BUILDING STRUCTURE TO INSURE CODE COMPLIANCE.
- D- CEILING DIFFUSERS ARE SHOWN IN APPROXIMATE LOCATIONS. REFER TO LIGHTING PLANS AND REFLECTED CEILING PLAN FOR EXACT LOCATIONS.
- E- DUCT DIMENSIONS CALLED OUT ON DRAWINGS ARE INSIDE FREE AREA DIMENSIONS. ACOUSTICAL DUCT LINER ARE TO BE ADDED TO OVERALL MEASUREMENTS.
- ALL DUCTWORK AND PIPING WHICH PASSES THRU FIRE RATED WALLS TO BE FIRE STOPPED WITH APPROVED FOAM OR SEALANT. REFER TO SPECIFICATIONS FOR APPROVED





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Drawing Number:

Job Number:

Revisions:

Drawn By:

Checked By: